
EPA Green Infrastructure City of Providence Education and Outreach Project MASHAPAUG POND STORMWATER BMP

Providence, Rhode Island Niantic Avenue & Swanton Street

APRIL 2014, DRAFT, NOT FOR CONSTRUCTION

SHEET	<u>TITLE</u>
C-1	EXISTING CONDITIONS AND EROSION CONTROLS
C-2	PROPOSED CONDITIONS
C-3	LANDSCAPING AND SURFACE TREATMENTS
C-4	CONSTRUCTION DETAILS
C-5	CONSTRUCTION DETAILS

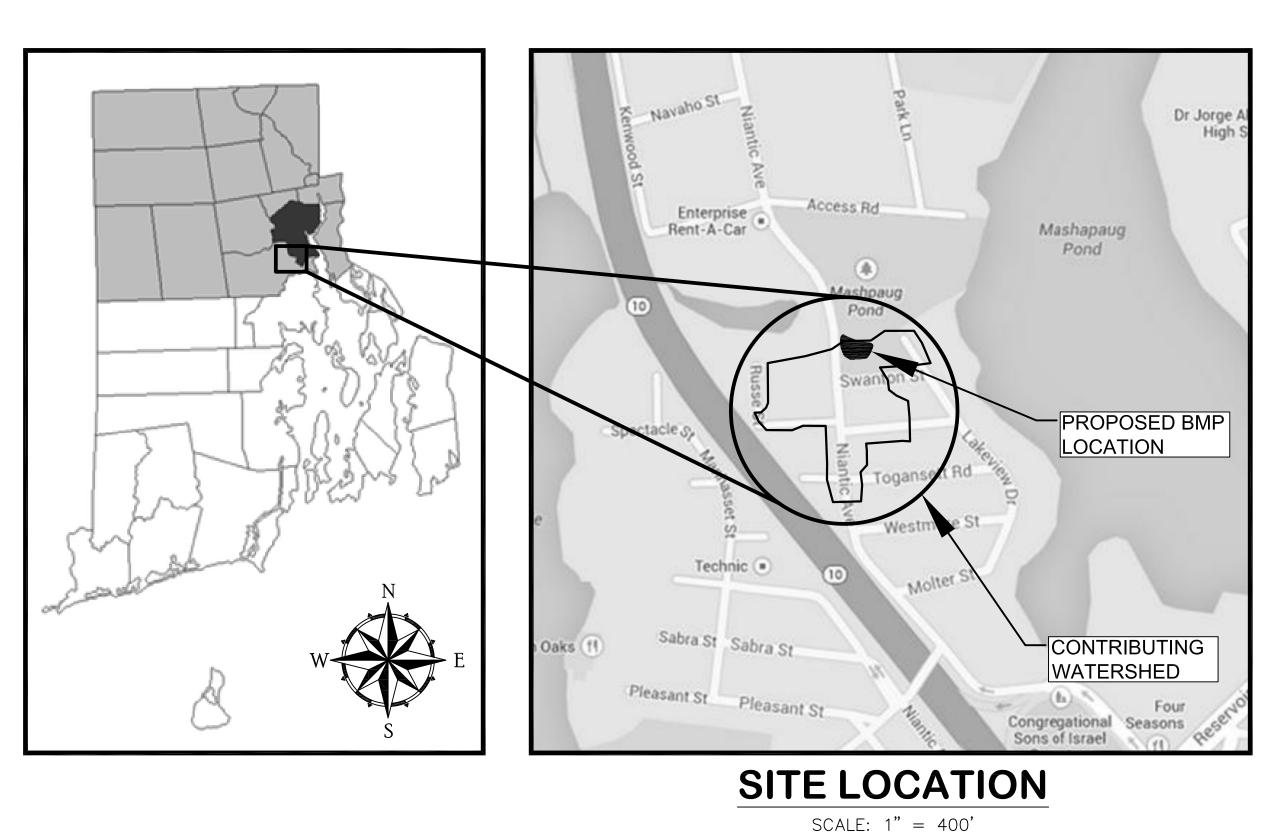




5 POST OFFICE SQUARE, SUITE 100 BOSTON, MA 02109



481 GREAT ROAD, SUITE 3 ACTON, MA 01720



21 DEPOT STREET MERRIMACK, NH 03054

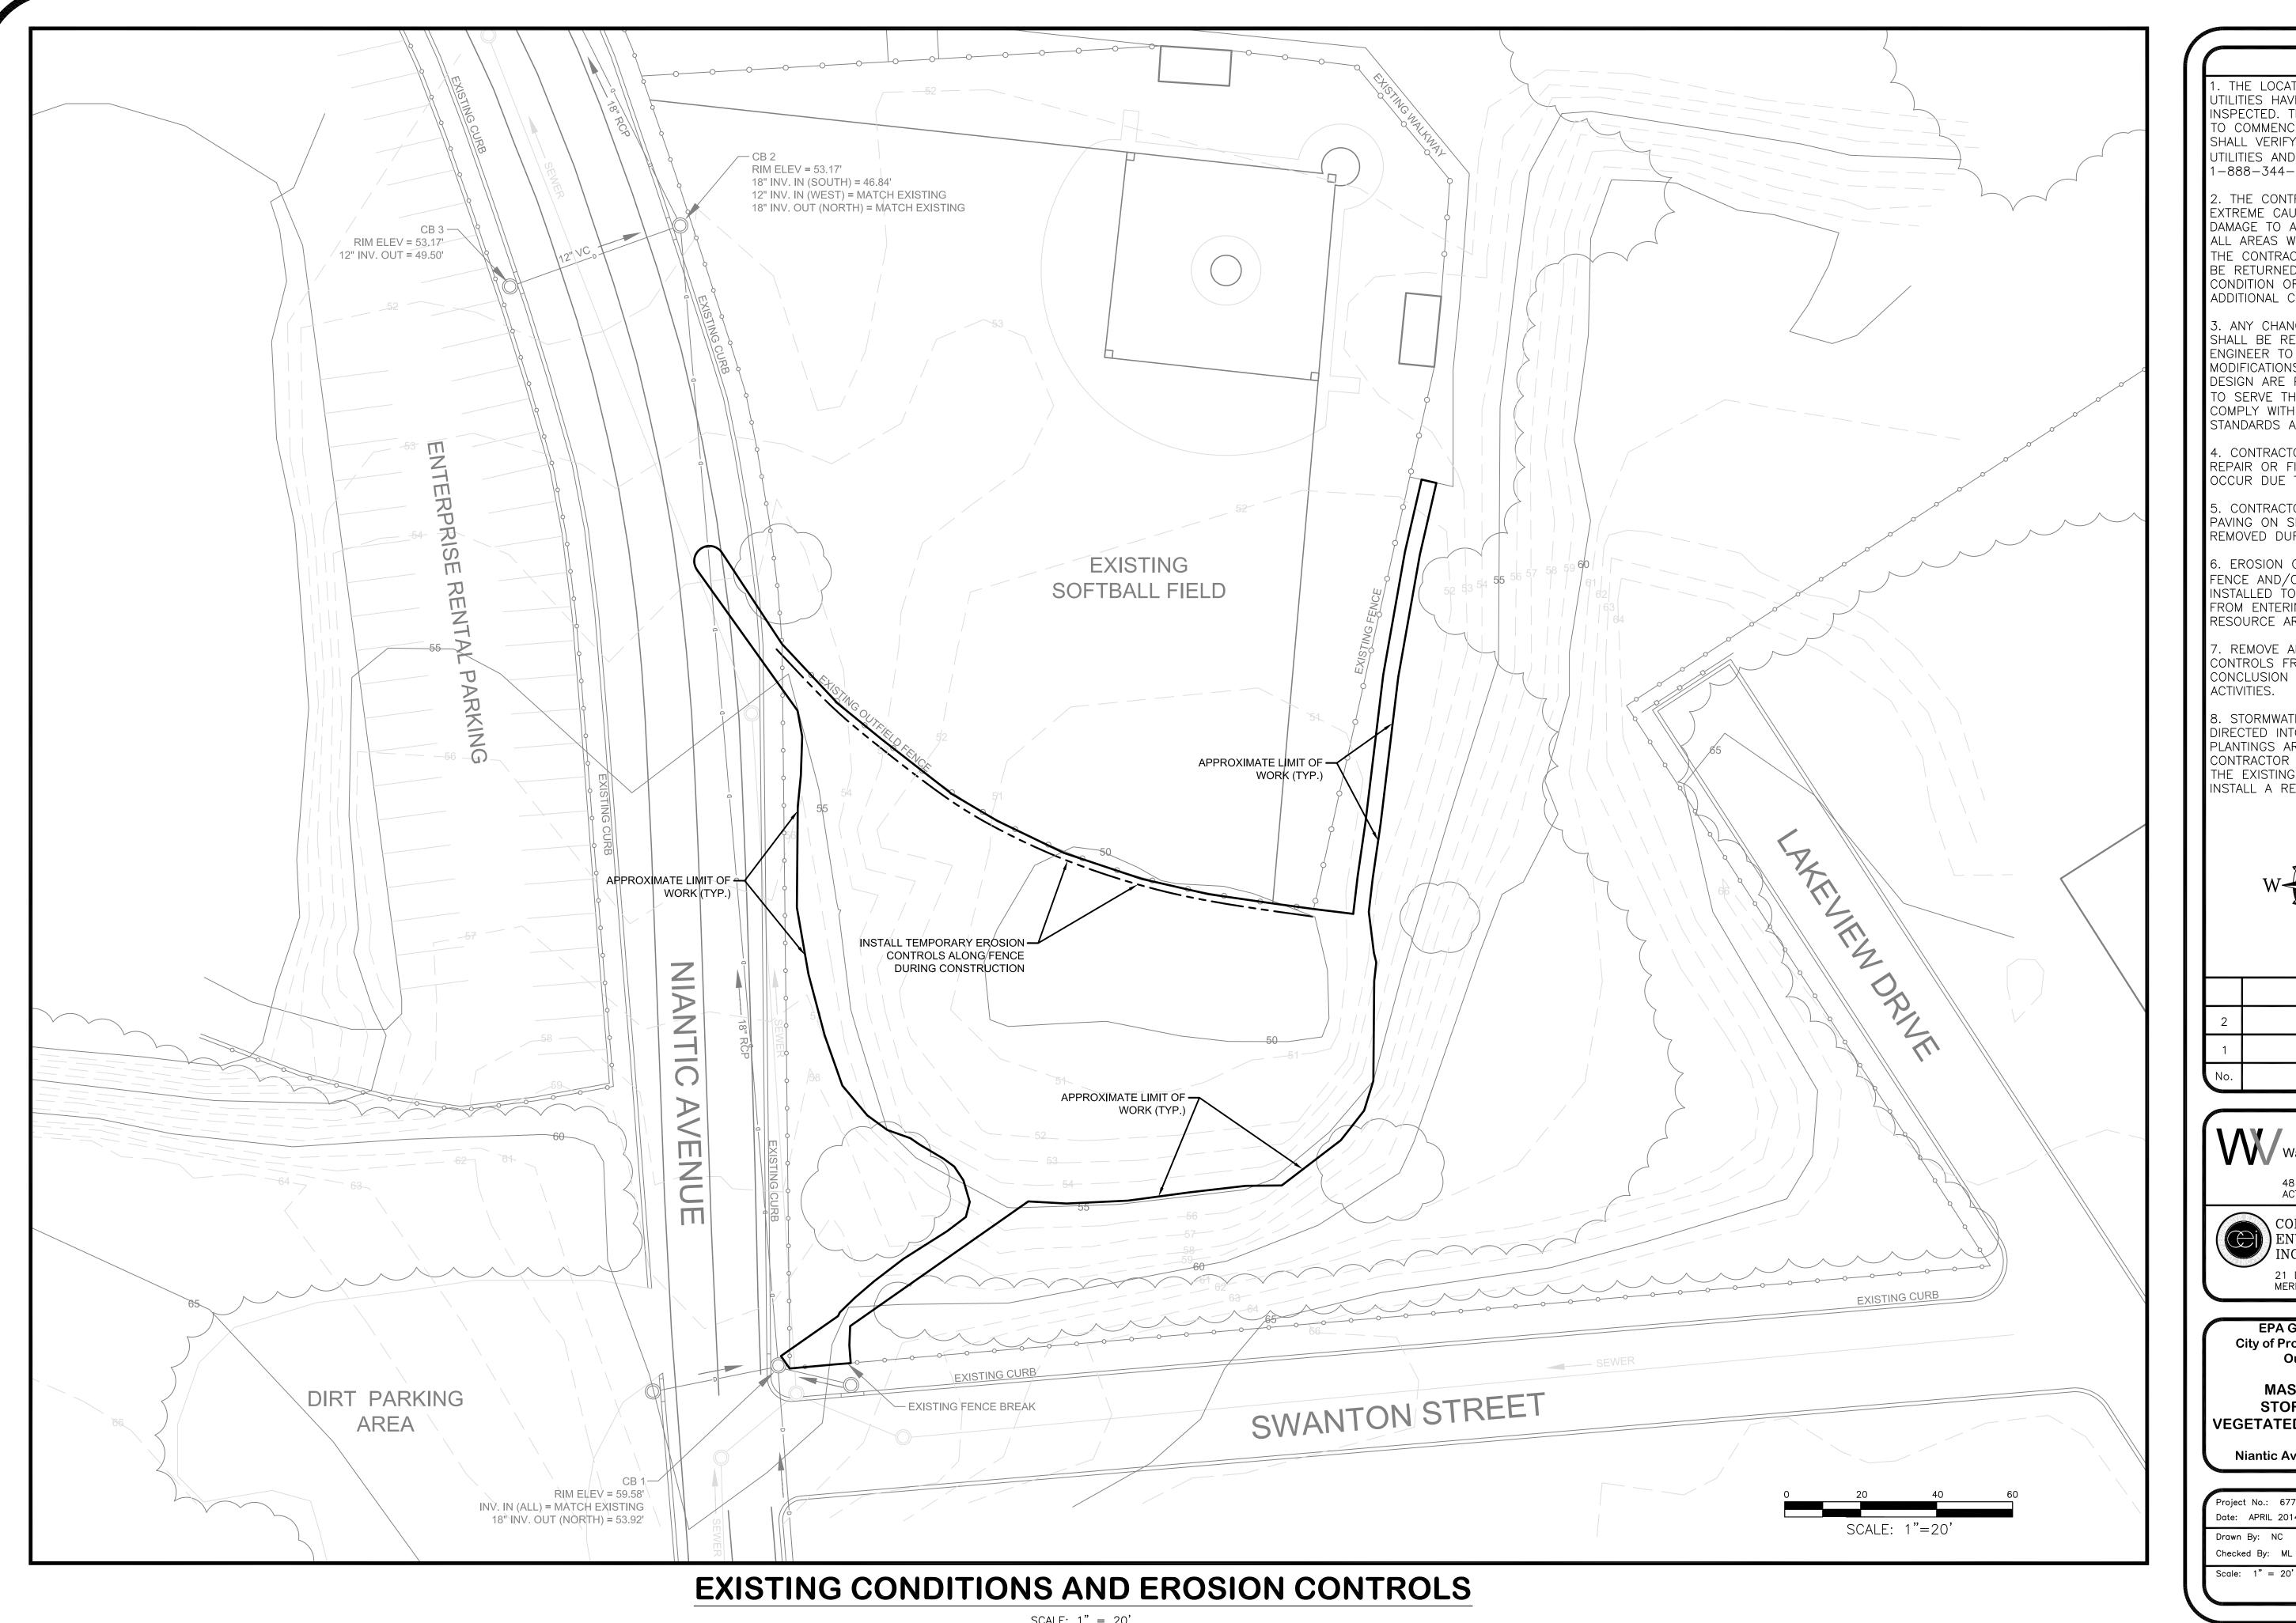

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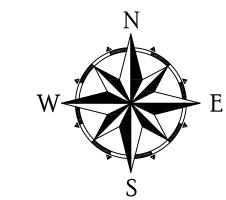
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		2	Final Design	04/14
		1	Conceptual	02/14
	Į.	No.	Revision/Issue	Date

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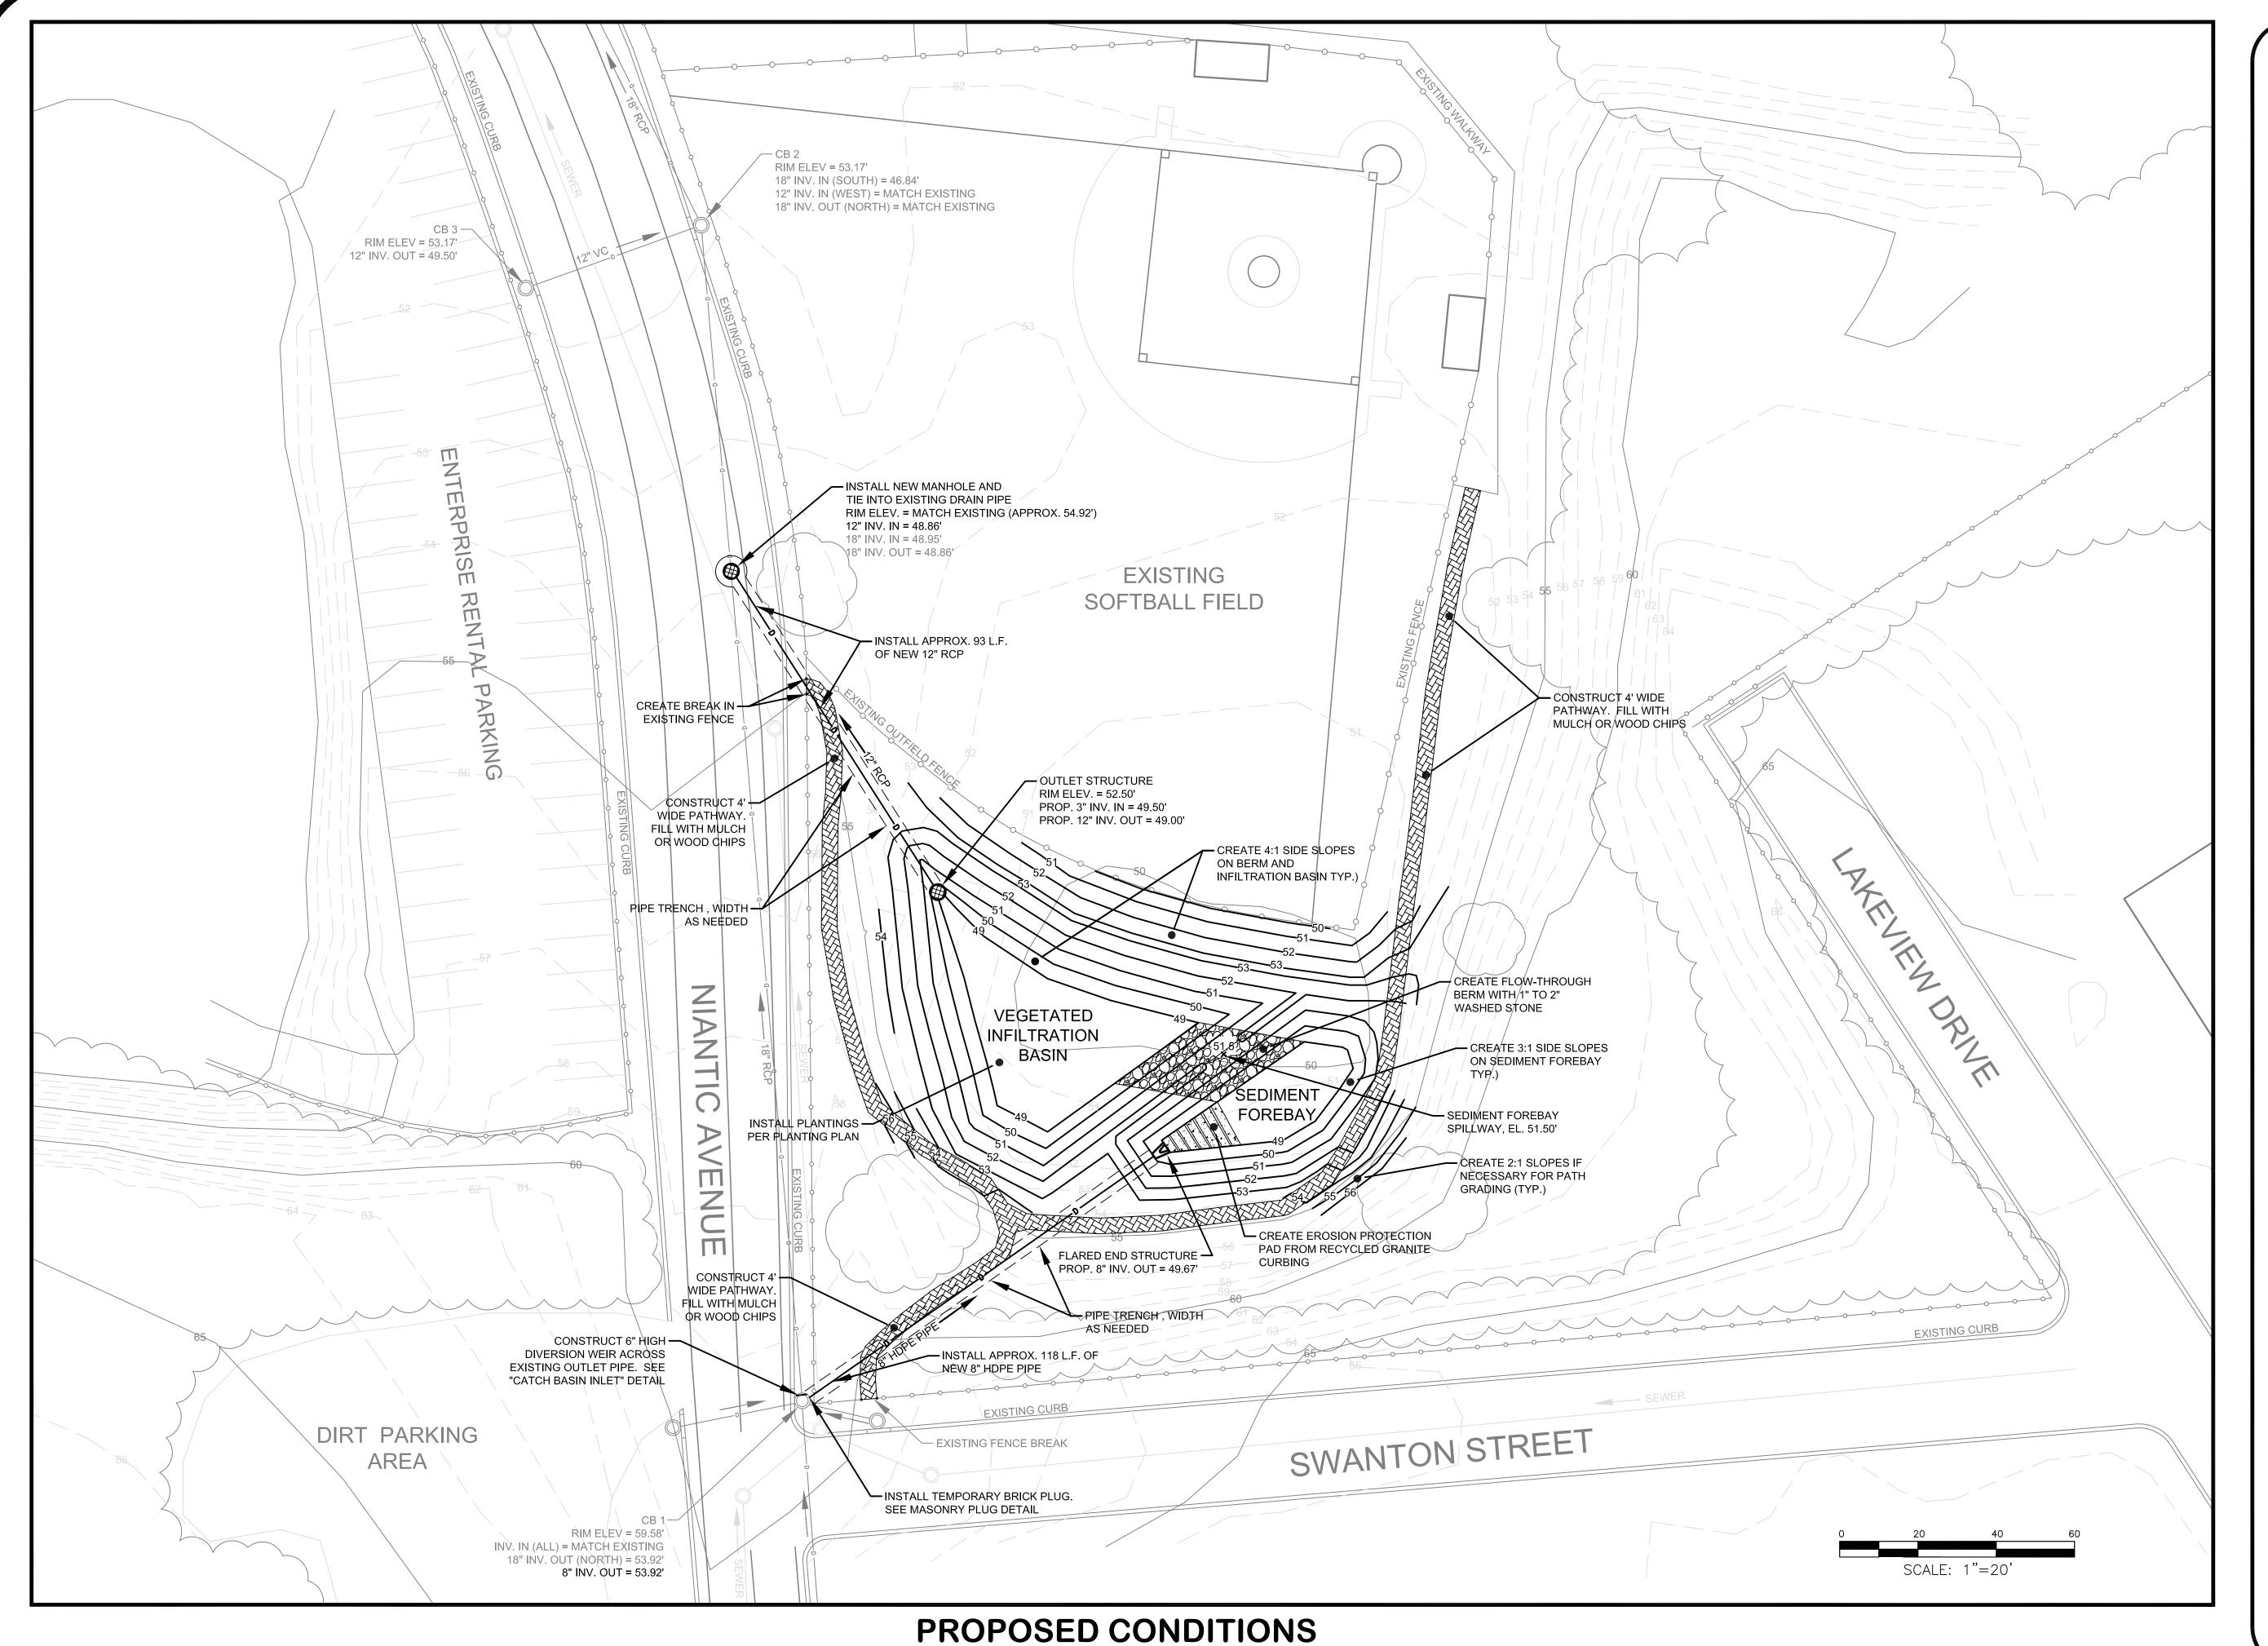
MASHAPAUG POND STORMWATER BMP -**VEGETATED INFILTRATION BASIN**

Niantic Avenue & Swanton Street

Date: APRIL 2014 Drawn By: NC Checked By: ML

C-1 Sheet 2 OF 6

SCALE: 1" = 20'



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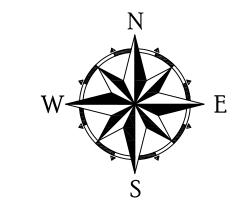
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COMPREHENSIVE ENVIRONMENTAL INCORPORATED

21 DEPOT STREET MERRIMACK, NH 03054

EPA Green Infrastructure
City of Providence Education and
Outreach Project

MASHAPAUG POND STORMWATER BMP -VEGETATED INFILTRATION BASIN

Niantic Avenue & Swanton Street


Project No.: 677-1
Date: APRIL 2014

Drawn By: NC
Checked By: ML

Scale: 1" = 20'

Sheet 3 OF 6

SCALE: 1" = 20'

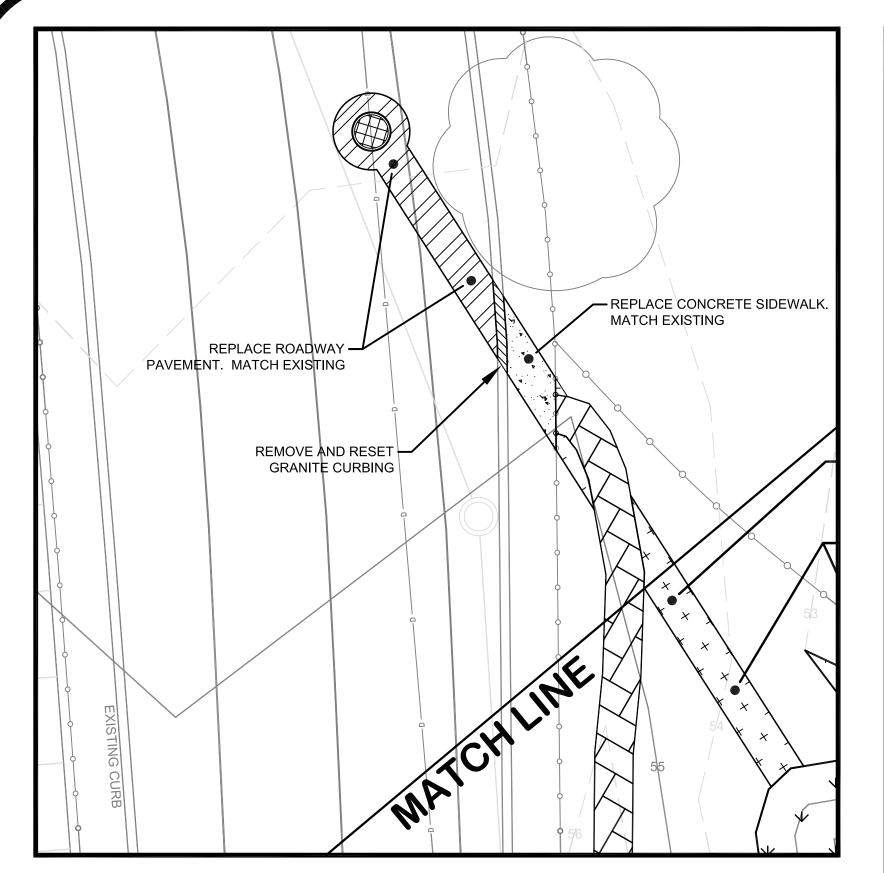


PAVEMENT AT PROP. DRAINAGE TIE-IN

SCALE: 1" = 10'


58 SY.

PLANTING SCHEDULE PLANT TYPE Ceanothus americanus (NEW JERSEY TEA) Clethra alnifolia (SWEET PEPPERBUSH) Spiraea latifolia (MEADOWSWEET) Lyonia ligustrina (MALEBERRY) OUANTITY QUANTITY 5 EA.

SURFACE TREATMENT				
<u>TYPE</u>	AREA			
REPLACEMENT PAVEMENT	15 SY.			
REPLACEMENT CONCRETE SIDEWALK	5 SY.			
MULCH OR WOOD CHIPS	216 SY.			
+ + + RESTORATION SEED MIX (UPLAND AREAS)	223 SY.			
BASIN SEED MIX (INFILTRATION BASIN)	172 SY.			
BASIN SEED MIX (SIDE SLOPES)	608 SY.			

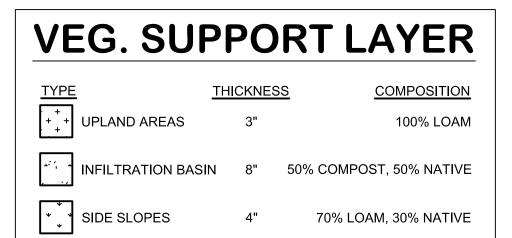

NON-WOVEN FILTER FABRIC

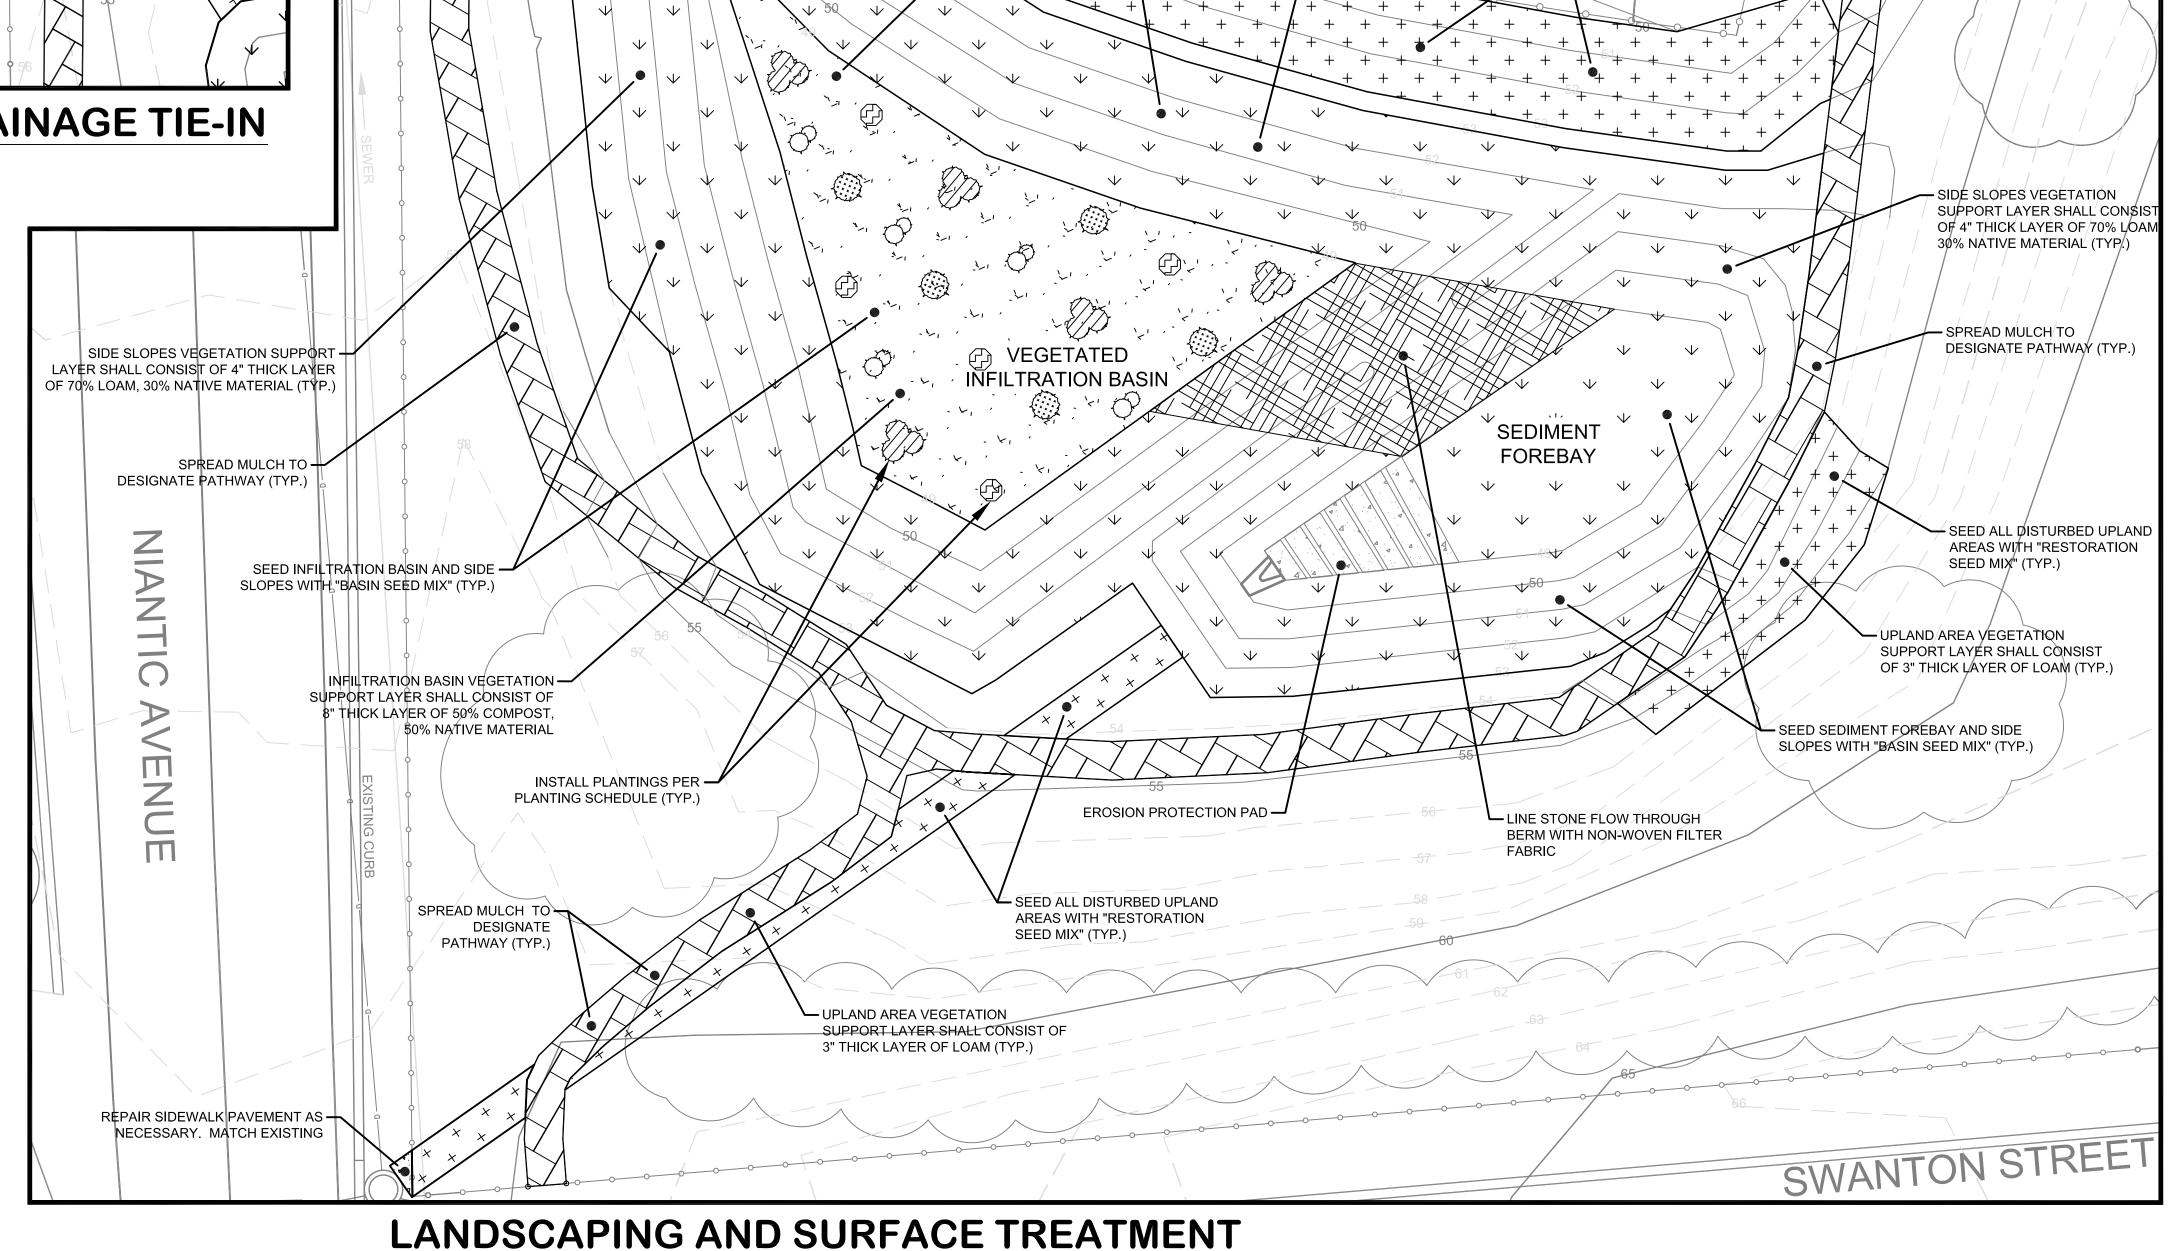

EXISTING

SOFTBALL FIELD

SIDE SLOPES VEGETATION SUPPORT

LAYER SHALL CONSIST OF 4" THICK LAYER

OF 70% LOAM, 30% NATIVE MATERIAL (TYP.)

- SEED ALL DISTURBED UPLAND

AREAS WITH "RESTORATION

SEED MIX" (TYP.)

UPLAND AREA VEGETATION SUPPORT

LAYER SHALL CONSIST OF 3" THICK

- SEED INFILTRATION BASIN AND SIDE

SLOPES WITH "BASIN SEED MIX" (TYP.)

LAYER OF LOAM (TYP.)

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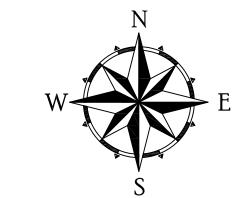
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City of Providence Education and
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MASHAPAUG POND STORMWATER BMP -VEGETATED INFILTRATION BASIN

Niantic Avenue & Swanton Street

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Scale: 1" = 10'	Shoot 4 OF
	Sheet 4 OF

SCALE: 1" = 10'

REPLACE CONCRETE SIDEWALK.

- UPLAND AREA VEGETATION

SEED ALL DISTURBED UPLAND


AREAS WITH "RESTORATION

SEED MIX" (TYP.)/

SUPPORT LAYER SHALL CONSIST


OF 3" THICK LAYER OF LOAM (TYP.)

MATCH EXISTING

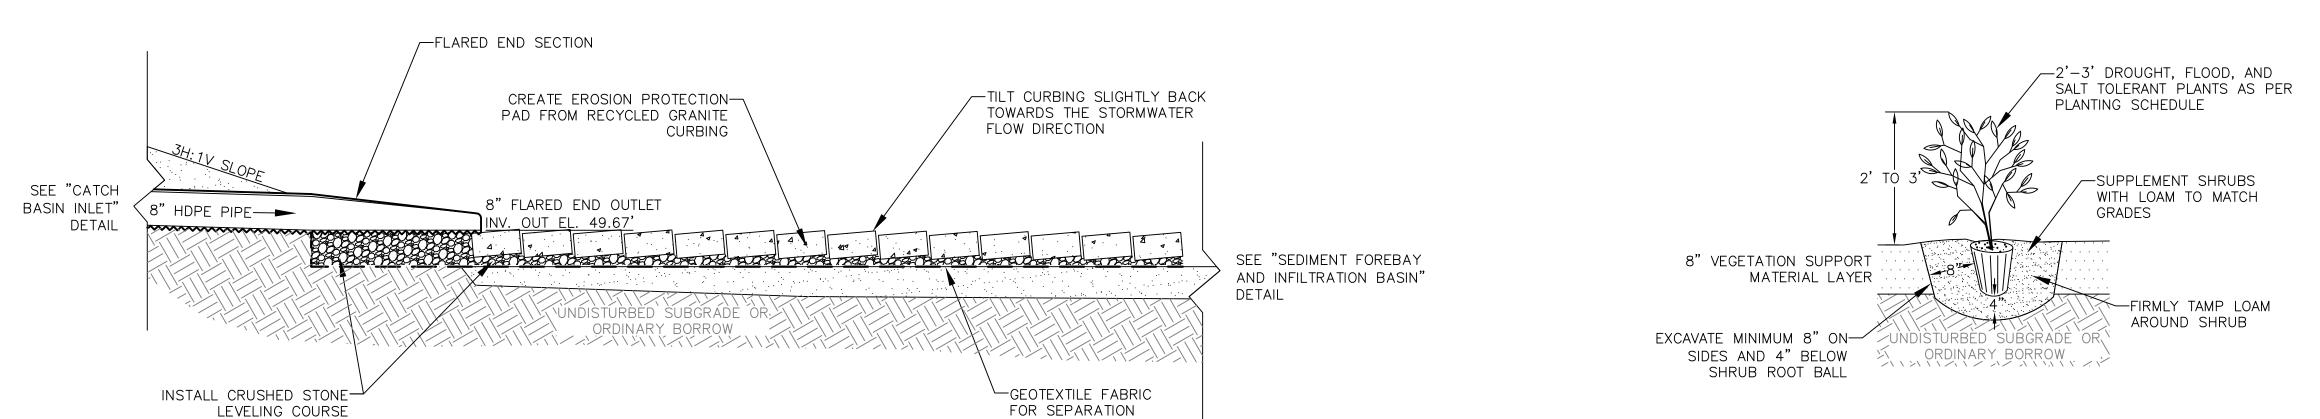

FLARED END SECTION

PROPOSED PLANTINGS

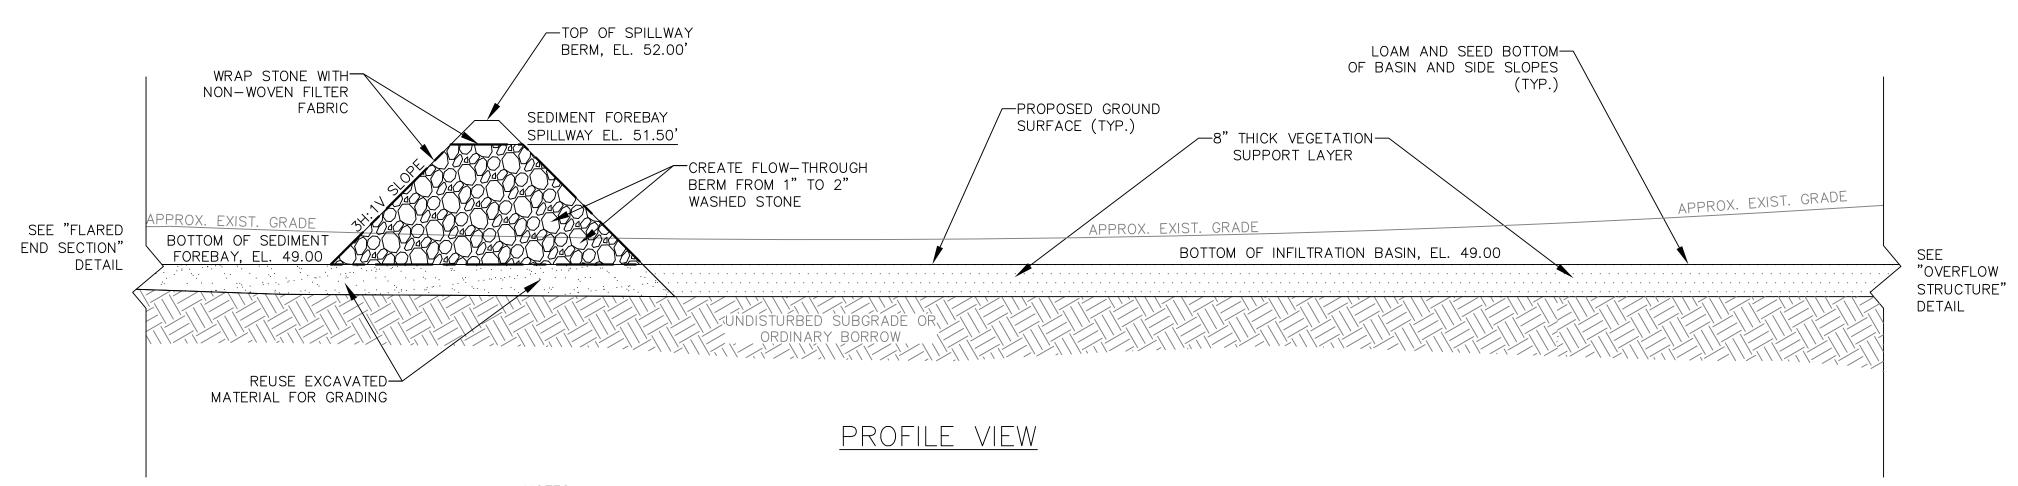


NOTES

1. DETAIL SHOWN AT APPROXIMATELY 1x HORIZONTAL TO 4x VERTICAL SCALE.

- 2. CONTRACTOR TO RESTRICT THE COMPACTION OF THE BASIN BOTTOM AND PREVENT ANY CONSTRUCTION EQUIPMENT FROM ENTERING THE BASIN.
- 3. CONTRACTOR SHALL TAKE EXTRA PRECAUTION NOT TO OVERCOMPACT BASIN EMBANKMENTS AND REDUCE THE INFILTRATIVE CAPACITY OF THE SOILS.

SEDIMENT FOREBAY AND INFILTRATION BASIN

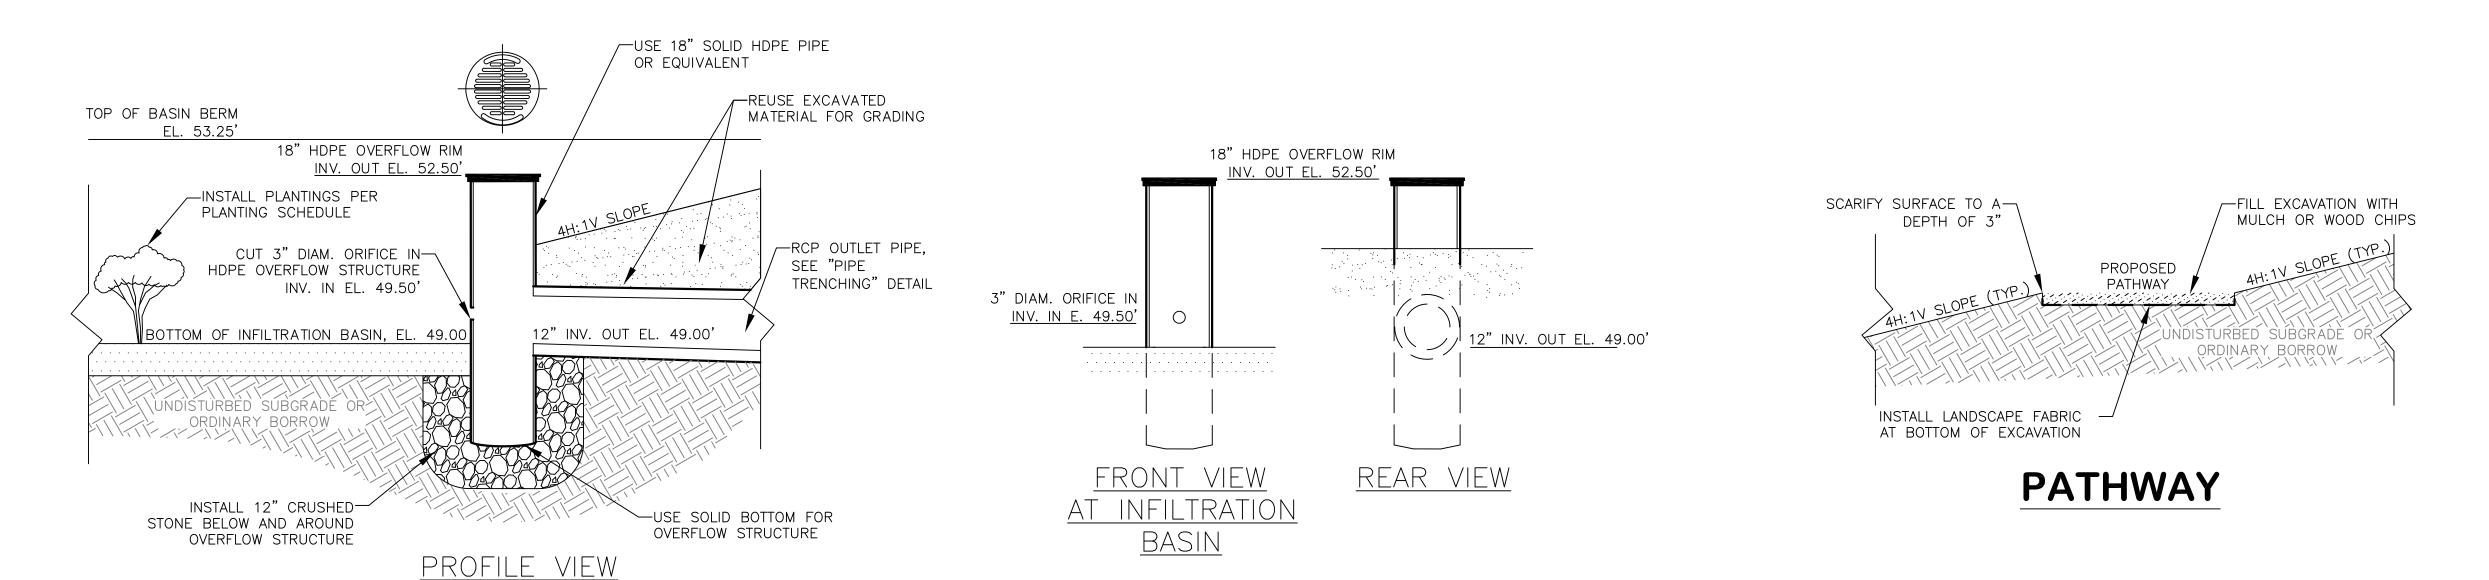

OVERFLOW STRUCTURE

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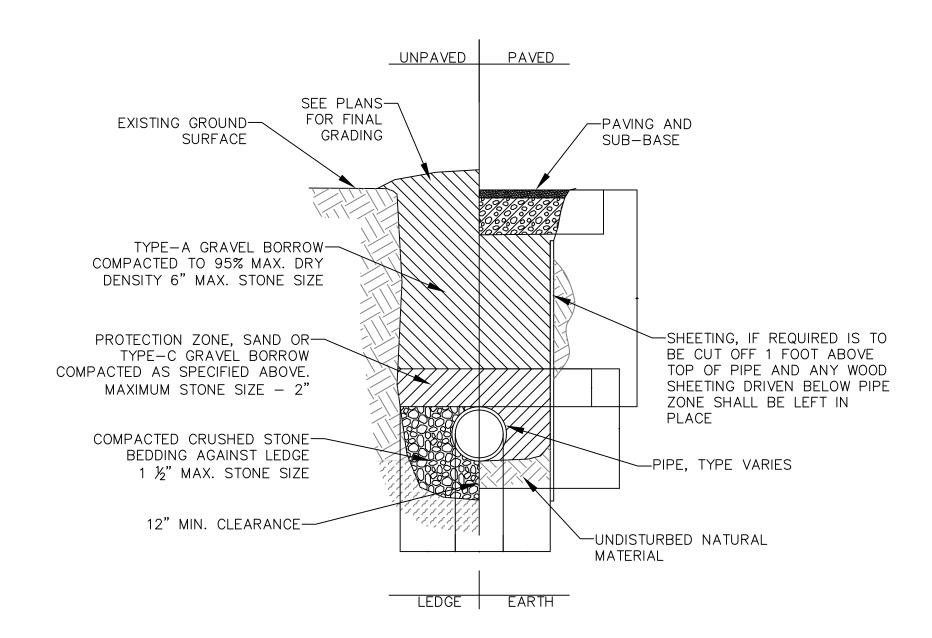
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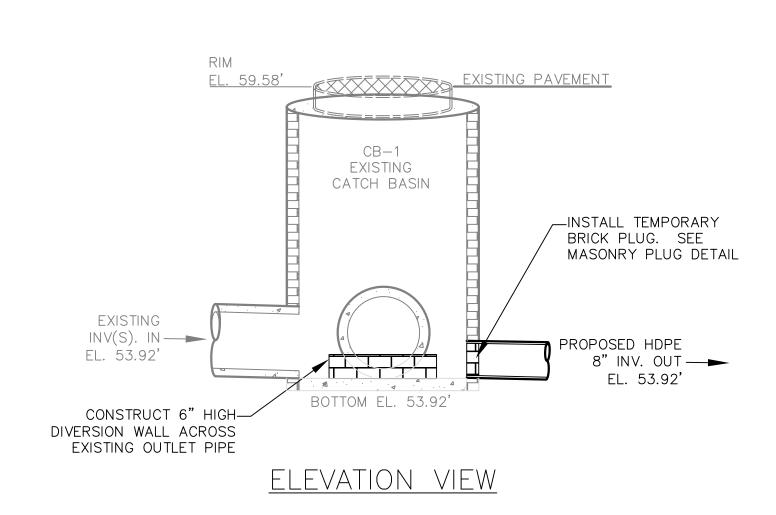
Outreach Project

Niantic Avenue & Swanton Street

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Scale: 1" = 20'	Shoot F OF
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PIPE TRENCH



BOTTOM OF

EXISTING CB AND

ALL INVERTS

EL. 53.92'

TOP VIEW

CONSTRUCT 6" HIGH-

DIVERSION WALL ACROSS EXISTING OUTLET PIPE

_INSTALL NEW 8" HDPE

DRAIN PIPE OR EQUIVALENT

—INSTALL TEMPORARY

MASONRY PLUG DETAIL


BRICK PLUG. SEE

DOWNSTREAM AREA TOP OF GROUND 1' (MIN.) WOOD STAKE OR APPROVED EQUAL WORK III WOR

NOTES

1. PUT ONE HAYBALE PERPENDICULAR ALONG HAYBALE BARRIER (100' O.C.)


CATCH BASIN INLET

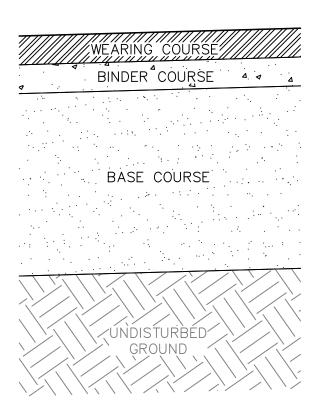


NOTES

1. PAVEMENT CROSS SECTION IS TYPICAL.
CONTRACTOR TO MATCH EXISTING CONDITIONS.

SILT FENCE EROSION CONTROLS REPLACEMENT PAVEMENT

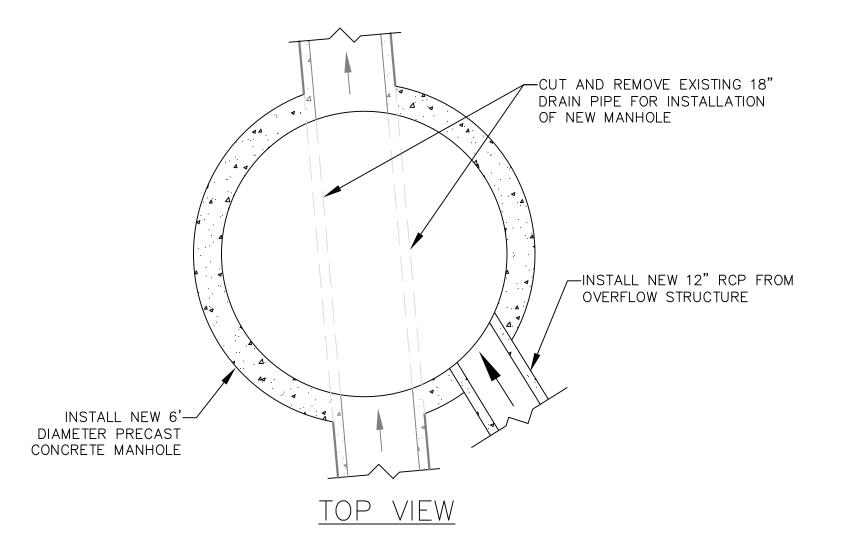

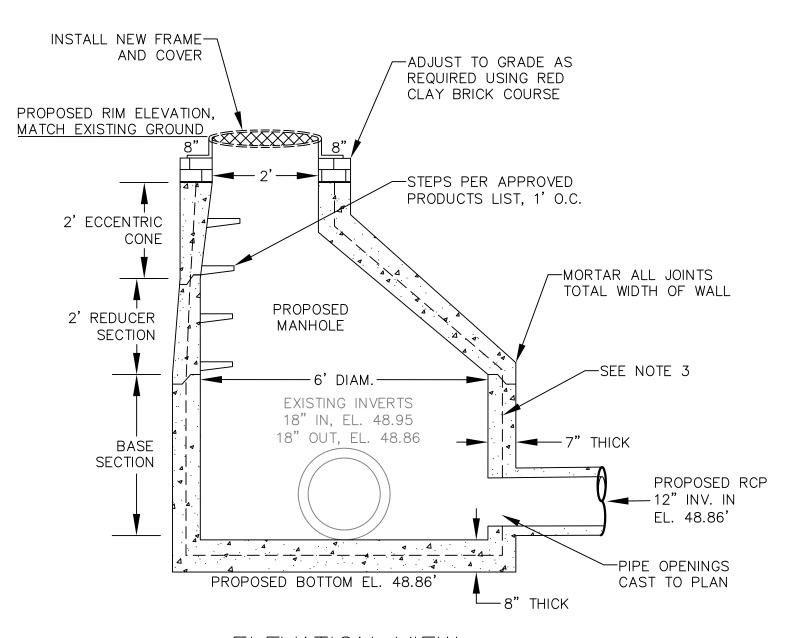

<u>ELEVATION VIEW</u>


- NOTES

 1. MANHOLE SHALL BE IN ACCORDANCE WITH SECTION 702 OF THE RI STANDARD
- SPECIFICATIONS

 2. CIRCUMFERENTIAL STEEL REINFORCEMENT REQUIRED = 0.15 SQ. IN./LF. MINIMUM

 3. STEEL BEINFORCEMENT FOR BASE SECTION BOTTOM SHALL BE A MINIMUM OF 0.12
- STEEL REINFORCEMENT FOR BASE SECTION BOTTOM SHALL BE A MINIMUM OF 0.12 SQ. IN./LF. (BOTH WAYS)
 ONE POUR MONOLITHIC BASE SECTION.
- 5. ANY NECESSARY ADJUSTMENTS DURING CONSTRUCTION WILL BE DONE BY SAW-CUTTING AND/OR CORING ONLY. NO JACKHAMMERS, HAMMERS AND CHISELS OR PNEUMATIC TOOLS WILL BE ALLOWED.
- WILL BE ALLOWED
 6. STEPS SHALL CONFORM TO STD. 5.3.0 AND SHALL BE INSTALLED AT THE CASTING PLANT

NEW MANHOLE TIE-IN

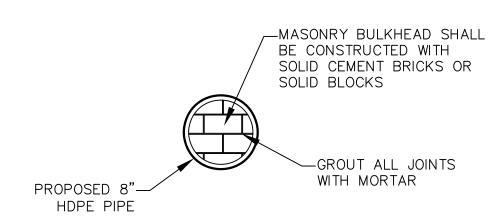

MASONRY PLUG

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